




FRONT ELEV

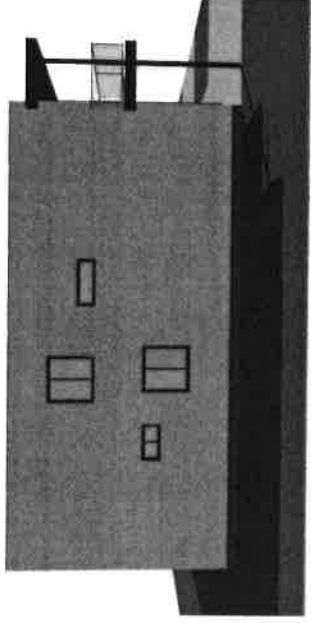

LEFT ELEV

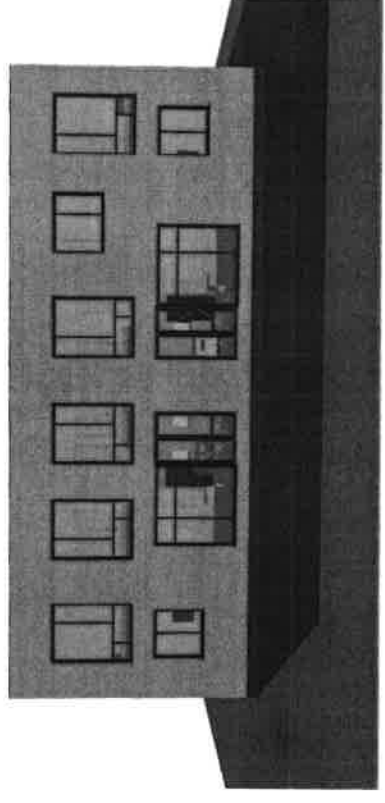

REAR ELEV

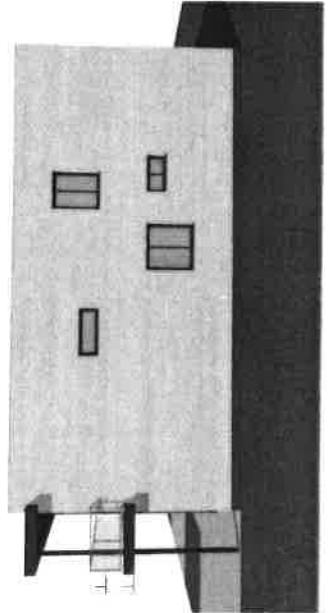

RIGHT ELEV

TABLE 1: AREA CALCULATIONS FOR EXTERIOR WALLS

Level	Area	Perimeter	Volume	Area
1st Floor	1,200	120	1,200	1,200
2nd Floor	1,200	120	1,200	1,200
3rd Floor	1,200	120	1,200	1,200
TOTAL	3,600	360	3,600	3,600

TABLE 2: AREA CALCULATIONS FOR INTERIOR WALLS

Level	Area	Perimeter	Volume	Area
1st Floor	1,200	120	1,200	1,200
2nd Floor	1,200	120	1,200	1,200
3rd Floor	1,200	120	1,200	1,200
TOTAL	3,600	360	3,600	3,600

© 2023 360 Architecture

360 ARCHITECTURE
 1000 10th Street, Suite 100
 San Francisco, CA 94103
 Tel: 415.555.1234
 Fax: 415.555.5678
 www.360architecture.com

PROJECT: 360 ARCHITECTURE
 ARCHITECT: 360 ARCHITECTURE
 DATE: 10/2023
 SCALE: 1/8" = 1'-0"

360 ARCHITECTURE
 1000 10th Street, Suite 100
 San Francisco, CA 94103
 Tel: 415.555.1234
 Fax: 415.555.5678
 www.360architecture.com


360 ARCHITECTURE
 1000 10th Street, Suite 100
 San Francisco, CA 94103
 Tel: 415.555.1234
 Fax: 415.555.5678
 www.360architecture.com

ELEVATIONS
 SHEET NO. A1

A1

APPENDIX B

9'-0" MAIN FLOOR
CEILING

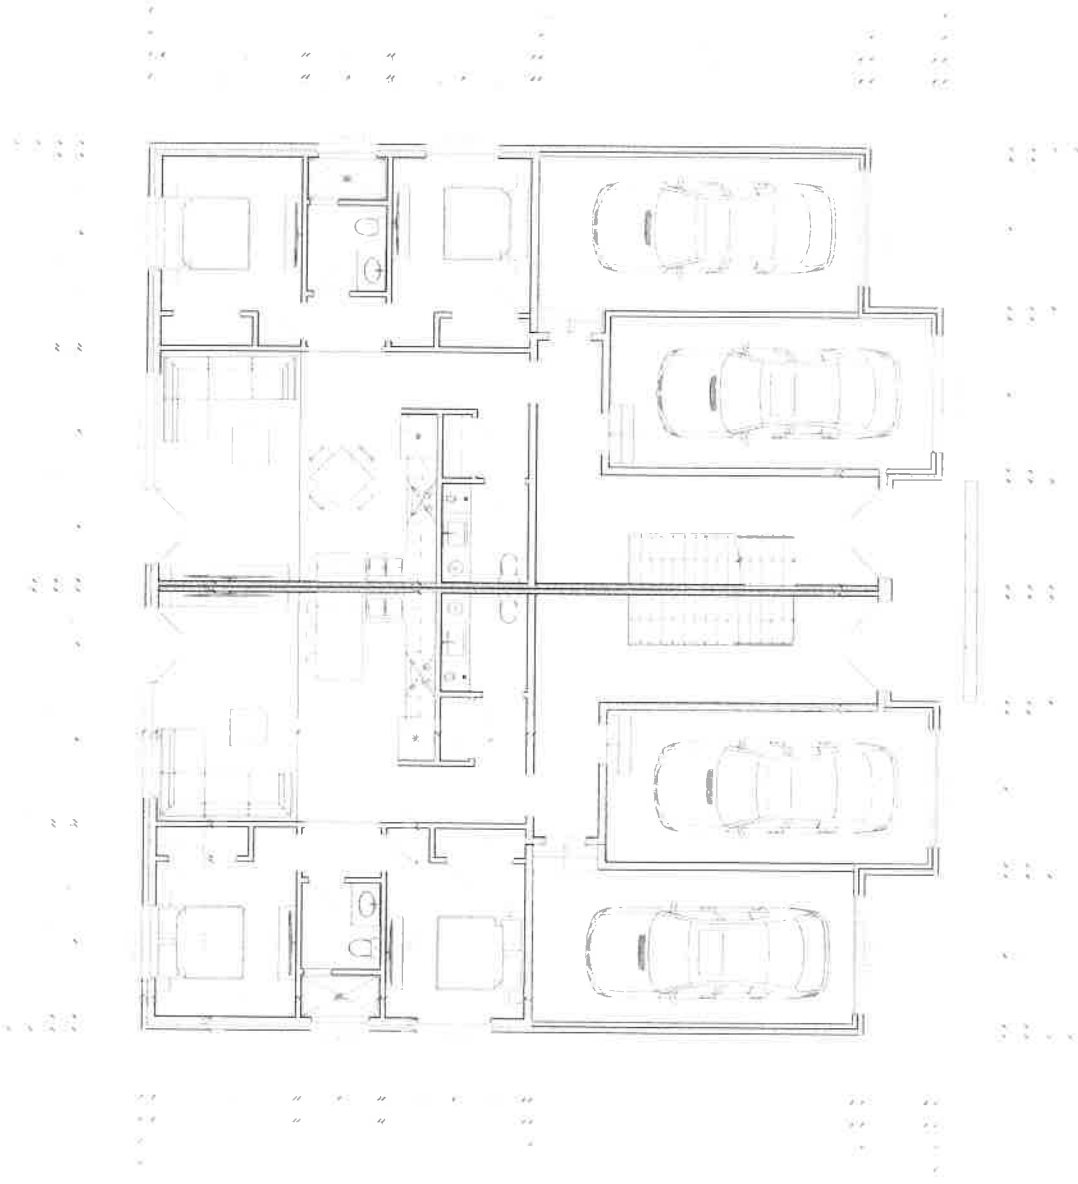

360
ARCHITECTURE
1000 15th Street, Suite 100
San Francisco, CA 94103
Tel: 415.774.3600
www.360arch.com

360
ARCHITECTURE
1000 15th Street, Suite 100
San Francisco, CA 94103
Tel: 415.774.3600
www.360arch.com

360
ARCHITECTURE
1000 15th Street, Suite 100
San Francisco, CA 94103
Tel: 415.774.3600
www.360arch.com

360
ARCHITECTURE
1000 15th Street, Suite 100
San Francisco, CA 94103
Tel: 415.774.3600
www.360arch.com

360
ARCHITECTURE
1000 15th Street, Suite 100
San Francisco, CA 94103
Tel: 415.774.3600
www.360arch.com

360
ARCHITECTURE
1000 15th Street, Suite 100
San Francisco, CA 94103
Tel: 415.774.3600
www.360arch.com

360
ARCHITECTURE
1000 15th Street, Suite 100
San Francisco, CA 94103
Tel: 415.774.3600
www.360arch.com

360
ARCHITECTURE
1000 15th Street, Suite 100
San Francisco, CA 94103
Tel: 415.774.3600
www.360arch.com

360
ARCHITECTURE
1000 15th Street, Suite 100
San Francisco, CA 94103
Tel: 415.774.3600
www.360arch.com


360
ARCHITECTURE
1000 15th Street, Suite 100
San Francisco, CA 94103
Tel: 415.774.3600
www.360arch.com

360
ARCHITECTURE
1000 15th Street, Suite 100
San Francisco, CA 94103
Tel: 415.774.3600
www.360arch.com

MAIN FLOOR PLAN

A3

9'-0" SECOND FLOOR
CEILING

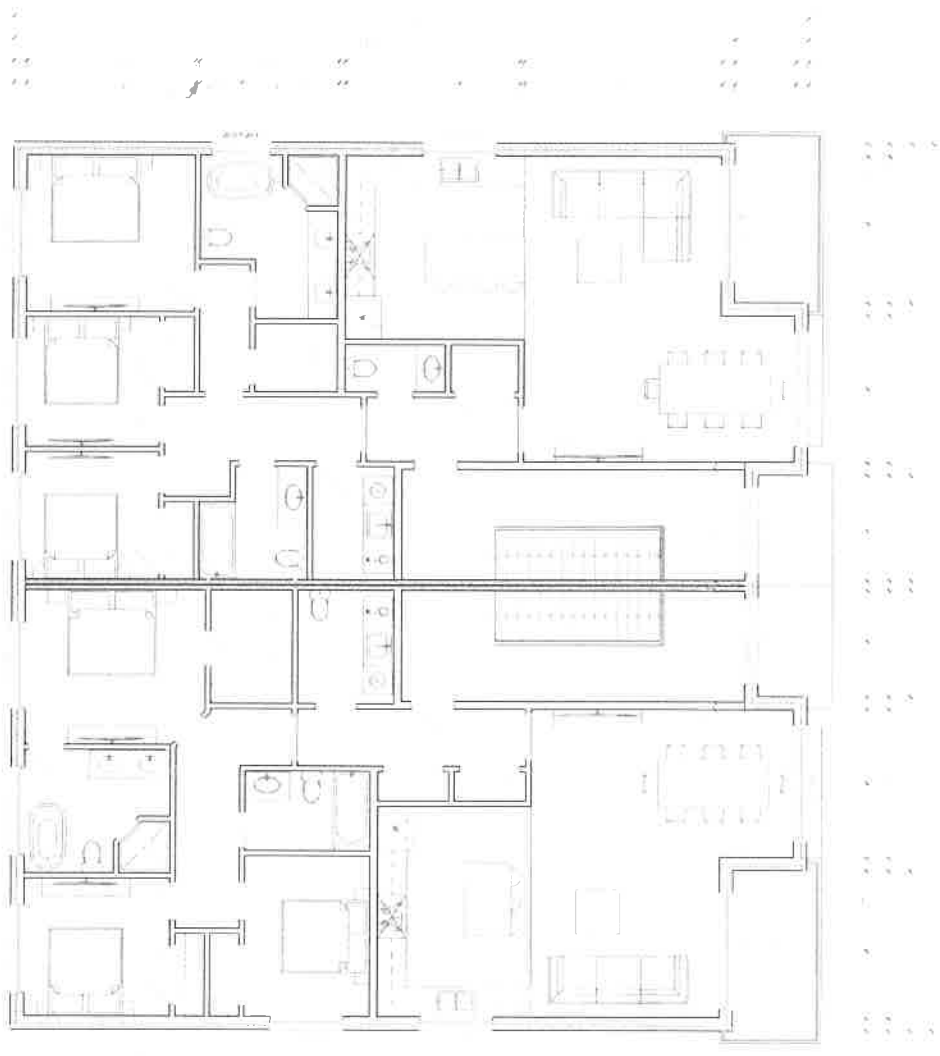

GENERAL NOTES:
 1. ALL WORK SHALL BE IN ACCORDANCE WITH THE MASSACHUSETTS BUILDING CODE, 248 CMR, AND ALL APPLICABLE LOCAL ORDINANCES.
 2. THE CONTRACTOR SHALL BE RESPONSIBLE FOR OBTAINING ALL NECESSARY PERMITS FROM THE LOCAL AUTHORITIES.
 3. ALL MATERIALS AND WORKMANSHIP SHALL BE SUBJECT TO INSPECTION AND APPROVAL BY THE LOCAL BUILDING DEPARTMENT.
 4. THE CONTRACTOR SHALL MAINTAIN ACCESS TO ALL ADJACENT PROPERTIES AT ALL TIMES.
 5. ALL UTILITIES SHALL BE PROTECTED AND NOT TO BE MOVED OR ALTERED WITHOUT THE WRITTEN APPROVAL OF THE ENGINEER.
 6. THE CONTRACTOR SHALL BE RESPONSIBLE FOR PROTECTING ALL EXISTING UTILITIES AND STRUCTURES.
 7. ALL WORK SHALL BE COMPLETED WITHIN THE SPECIFIED TIME FRAME.
 8. THE CONTRACTOR SHALL MAINTAIN A CLEAN WORK SITE AT ALL TIMES.
 9. ALL MATERIALS SHALL BE STORED PROPERLY ON SITE.
 10. THE CONTRACTOR SHALL BE RESPONSIBLE FOR OBTAINING ALL NECESSARY INSURANCE COVERAGE.
 11. ALL WORK SHALL BE COMPLETED IN ACCORDANCE WITH THE SPECIFICATIONS AND DRAWINGS.
 12. THE CONTRACTOR SHALL BE RESPONSIBLE FOR OBTAINING ALL NECESSARY APPROVALS FROM THE LOCAL AUTHORITIES.
 13. ALL WORK SHALL BE COMPLETED WITHIN THE SPECIFIED TIME FRAME.
 14. THE CONTRACTOR SHALL MAINTAIN A CLEAN WORK SITE AT ALL TIMES.
 15. ALL MATERIALS SHALL BE STORED PROPERLY ON SITE.
 16. THE CONTRACTOR SHALL BE RESPONSIBLE FOR OBTAINING ALL NECESSARY INSURANCE COVERAGE.
 17. ALL WORK SHALL BE COMPLETED IN ACCORDANCE WITH THE SPECIFICATIONS AND DRAWINGS.
 18. THE CONTRACTOR SHALL BE RESPONSIBLE FOR OBTAINING ALL NECESSARY APPROVALS FROM THE LOCAL AUTHORITIES.

360
 PROFESSIONAL ENGINEERING
 ARCHITECTURE
 INTERIORS
 360 ARCHITECTURE & INTERIORS, INC.
 100 STATE STREET, SUITE 200
 CAMBRIDGE, MASSACHUSETTS 02142
 (617) 552-3600
 WWW.360ARCHITECTURE.COM

360
 PROFESSIONAL ENGINEERING
 ARCHITECTURE
 INTERIORS
 360 ARCHITECTURE & INTERIORS, INC.
 100 STATE STREET, SUITE 200
 CAMBRIDGE, MASSACHUSETTS 02142
 (617) 552-3600
 WWW.360ARCHITECTURE.COM

PROJECT: 02-2020-001
 DRAWING NO: 20-01
 SHEET NO: 10 OF 12
 DATE: 02/10/2020


SECOND FLOOR PLAN

Scale:	As Shown
Author:	360 Architecture & Interiors
Checker:	360 Architecture & Interiors
Designer:	360 Architecture & Interiors
Project Manager:	360 Architecture & Interiors

A4

8'-0" BASEMENT WALLS

UNIT SCHEDULES	
1	8'-0" BASEMENT WALL
2	8'-0" BASEMENT WALL
3	8'-0" BASEMENT WALL
100	8'-0" BASEMENT WALL

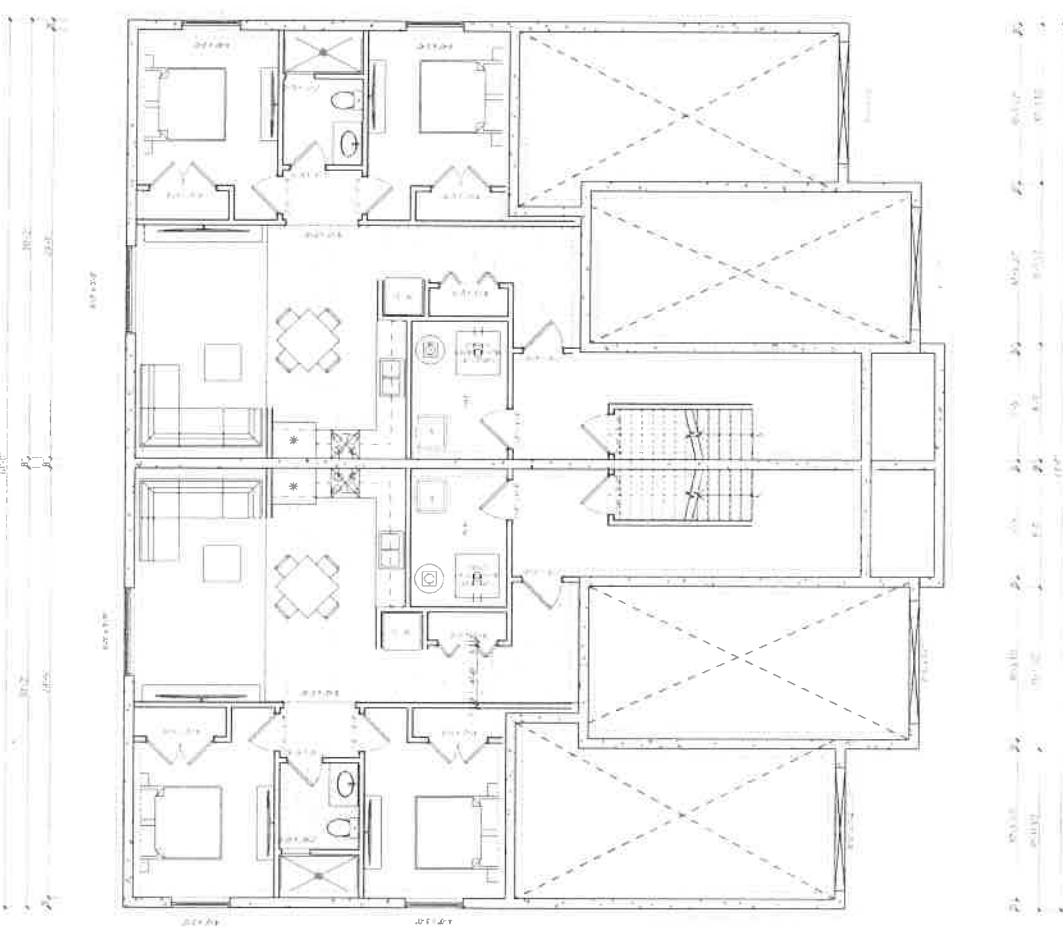

360
ARCHITECTURE

360
ARCHITECTURE

360
ARCHITECTURE

360 ARCHITECTURE
100 SPRING STREET
CAMBRIDGE MA 02142
TEL: 617.552.3600
WWW.360ARCHITECTURE.COM

360 CONSULTING
 10000 14th Street, Suite 100
 Edmonton, Alberta T5M 2L7
 Tel: 780-443-3600
 Fax: 780-443-3601
 www.360consulting.com

360 CONSULTING
 10000 14th Street, Suite 100
 Edmonton, Alberta T5M 2L7
 Tel: 780-443-3600
 Fax: 780-443-3601
 www.360consulting.com

360 CONSULTING
 10000 14th Street, Suite 100
 Edmonton, Alberta T5M 2L7
 Tel: 780-443-3600
 Fax: 780-443-3601
 www.360consulting.com

SITE PLAN
 A5

